

A Division of PORTERCORP 4240 N. 136th AVE HOLLAND, MI 49424 (616) 888-3500

PROJECT NAME: PARLEY'S CREEK


PROJECT LOCATION: SALT LAKE CITY, UT

BUILDING TYPE: REK 40X64

ROOF TYPE: STANDING SEAM (24 GA) OVER STAINED T & G

BUILDING NUMBER: P21135

81859 ORDER NUMBER:

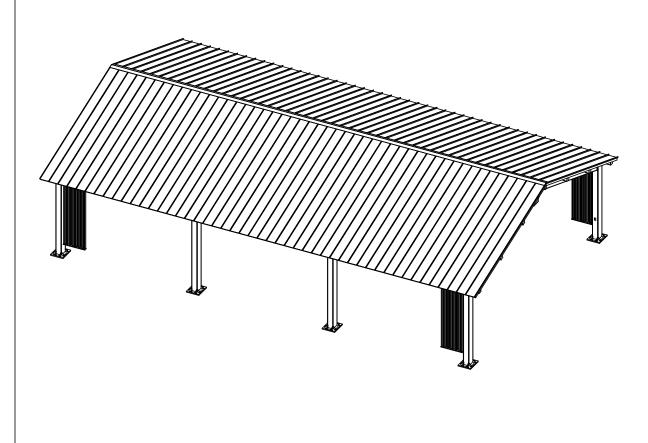

DRAWING LIST:

SHEET NUMBER	DRAWING DESCRIPTION
CS	COVER SHEET
1	ARCHITECTURAL ELEVATIONS
2-2.1	ANCHOR AND FOOTING LAYOUT / DETAILS
3-3.1	STRUCTURAL FRAMING PLAN
4-4.2	FRAME CONNECTION DETAILS
5-5.1	ELECTRICAL VIEWS
6-6.2	ROOF LAYOUT
7-7.3	ROOF CONNECTION DETAILS

MANUFACTURER NOTES:

MATERIALS:

DESCRIPTION	<u>ASTM DESIGNATION</u>
TUBE STEEL	A500 (GRADE C)
SCHEDULE PIPE	A53 (GRADE B)
RMT PIPE	A519
LIGHT GAGE COLD FORMED	A1003 (GRADE 50)
STRUCTURAL STEEL PLATE	A36
ROOF PANELS (STEEL)	A653
ANCHOR BOLTS	SEE SHEET 2.1


- GENERAL NOTES:


 UNLESS NOTED OTHERWISE, THIS STRUCTURE WAS DESIGNED TO ONLY SUPPORT WHAT IS SHOWN ON THESE DRAWINGS. POLIGON MUST BE CONTACTED IF ANYTHING ELSE IS TO BE ATTACHED TO THIS STRUCTURE (WALLS, COLUMN WRAPS, RAILINGS, ETC.) SO THE DESIGN OF THIS STRUCTURE CAN BE REVIEWED AND POSSIBLY REVISED.
 THE ENGINEERING SEAL FOR THE STRUCTURE DETAILED IN THESE DRAWINGS IS ONLY VALID IF PORTER CORP DESIGNS AND FABRICATES THE STEEL COMPONENTS. FABRICATING THE STEEL COMPONENTS ELSEWHERE VOIDS THE ENGINEERING PROVIDED BY PORTER CORP.
- BT PORTER CORP. UNLESS NOTED OTHERWISE, THIS STRUCTURE WAS DESIGNED ASSUMING A 20' SEPARATION BETWEEN ANY ADJACENT STRUCTURE WITH AN EAVE HEIGHT EQUAL TO OR GREATER THAN THE EAVE HEIGHT OF THIS STRUCTURE (SEE SNOW DESIGN DATA). IF THAT SEPARATION DOES NOT EXIST AND THE GROUND SNOW LOAD (Pg) IS GREATER THAN 0 3. PSF, POLIGON MUST BE CONTACTED SO THE DESIGN OF THIS STRUCTURE CAN BE REVIEWED AND POSSIBLY REVISED.
- STRUCTURAL STEEL SHALL BE DETAILED, FABRICATED, AND ERECTED IN ACCORDANCE 4. WITH THE AMERICAN INSTITUTE OF STEEL CONSTRUCTION (AISC) SPECIFICATION MANUAL REFERENCED IN THE GOVERNING BUILDING CODE.
- 5. ALL WELDING IS PERFORMED BY AMERICAN WELDING SOCIETY (AWS) CERTIFIED WELDERS AND CONFORMS TO AWS D1.1 OR D1.3 AS REQUIRED. PARTS SHOWN MAY BE UPGRADED DUE TO STANDARDIZED FABRICATION. REFER TO THE
- 6. SHIPPING BILL OF MATERIALS AND FINAL INSTALLATION INSTRUCTIONS INCLUDED WITH THE STRUCTURE FOR POSSIBLE SUBSTITUTIONS AND IMPROVEMENTS.
- 7. FOR PROPER FIELD INSTALLATION OF THE BUILDING IT IS RECOMMENDED THAT THE PRIMARY FRAME INSTALLER AND THE ROOF INSTALLER HAVE A MINIMUM FIVE (5) YEARS DOCUMENTED EXPERIENCE INSTALLING THIS TYPE OF PRODUCT.
- THE DRAWINGS REPRESENT THE FINISHED STRUCTURE. THE CONTRACTOR SHALL 8. SUPERVISE AND DIRECT THE WORK, AND SHALL BE SOLELY RESPONSIBLE FOR CONSTRUCTION MEANS, TECHNIQUES, SEQUENCES AND PROCEDURES, INCLUDING BRACING, SHORING, LAYDOWN AND PROTECTION OF CONSTRUCTION MATERIALS, ETC. TEMPORARY SHORING AND BRACING SHALL BE THE RESPONSIBILITY OF THE CONTRACTOR.
- FOR PROPER FIELD INSTALLATION OF THE BUILDING IT IS RECOMMENDED THAT ELECTRIC WIRING, IF REQUIRED, BE RUN THROUGH THE STRUCTURAL MEMBERS BEFORE THE 9. BUILDING IS ERECTED.
- MAKING HOLES, CUTS OR MODIFICATIONS TO THE STRUCTURAL STEEL MEMBERS IS NOT PERMITTED IN THE FIELD WITHOUT SPECIFIC APPROVAL OF POLIGON. 10.

CERTIFICATES: MIAMI-DADE COUNTY CERTIFICATE OF COMPETENCY NO. 24-0903.04 PCI (POWDER COATING INSTITUTE) 4000 CERTIFIED

EABRICATOR APPROVALS: CITY OF PHOENIX, AZ APPROVED FABRICATOR #C08-2010 CITY OF LOS ANGELES, CA APPROVED FABRICATOR #FB01596 CITY OF RIVERSIDE, CA APPROVED FABRICATOR #SF_000042 CITY OF HOUSTON, TX APPROVED FABRICATOR #470 CLARK COUNTY, NV APPROVED FABRICATOR #264 STATE OF UTAH APPROVED FABRICATOR 02008-14 AISC APPROVED FABRICATOR C-00024530 AWS CERTIFIED WELDING FABRICATOR #240707F




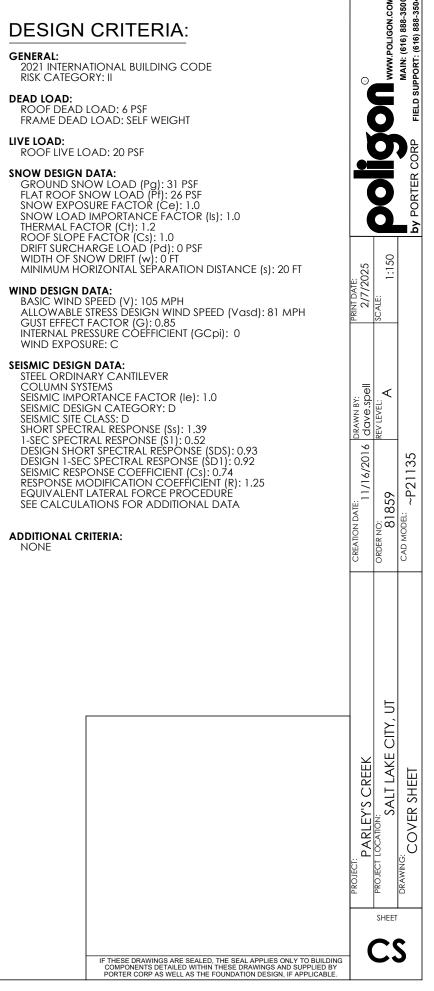

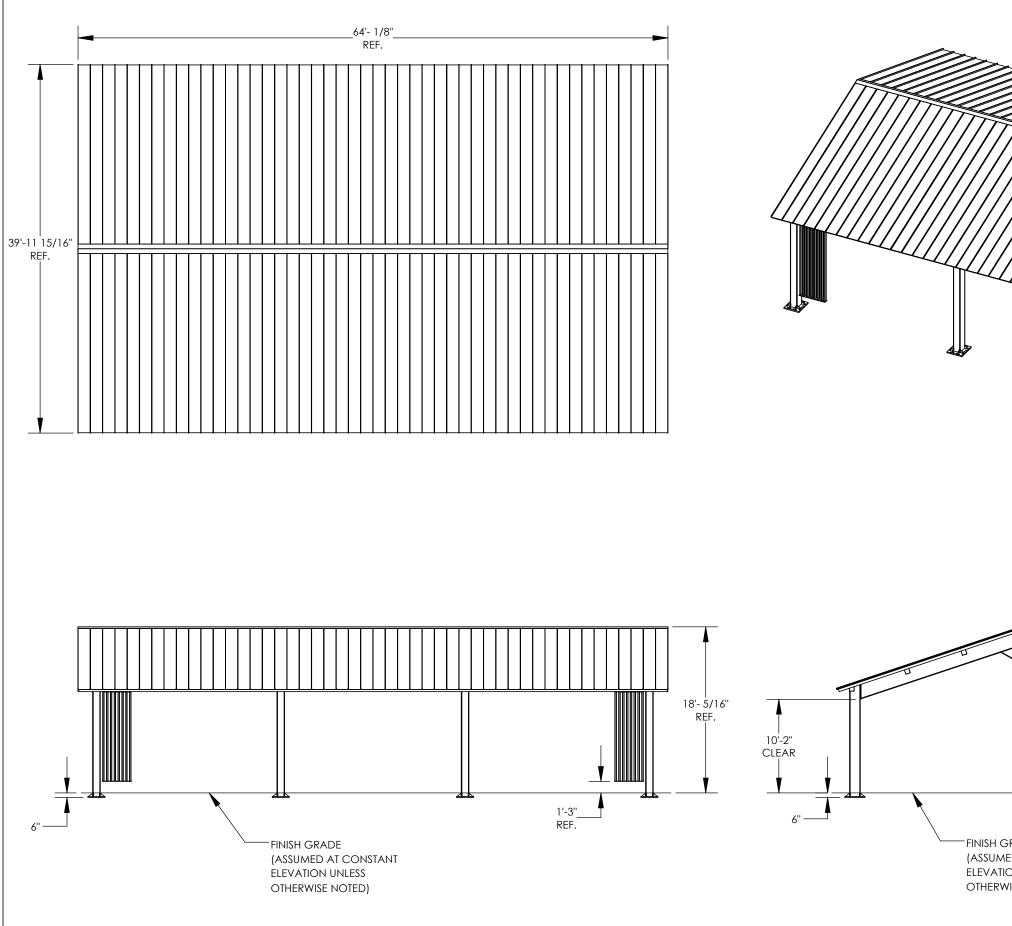


FINISH GRADE (ASSUMED AT CONSTANT ELEVATION UNLESS OTHERWISE NOTED)

	DDDDDDDDDDDDD WWW.POLIGON.COM MAIN. (616) 888-3500 By PORTER CORP FIELD SUPPORT: (616) 888-3500
	PRINT DATE: 2/7/2025 SCALE: 1:125
	CREATION DATE: DRAWN BY: 11/16/2016 DAVE.Spell ORDER NO: REV LEVEL: 81859 A CAD MODEL: ~P21135
	PROJECT: PROJECT LOCATION: PROJECT LOCATION: SALT LAKE CITY, UT DRAWING: ARCHITECTURAL ELEVATIONS
IF THESE DRAWINGS ARE SEALED, THE SEAL APPLIES ONLY TO BUILDING COMPONENTS (AND FOUNDATION DESIGN IF APPLICABLE) DETAILED WITHIN THESE DRAWINGS.	- 1

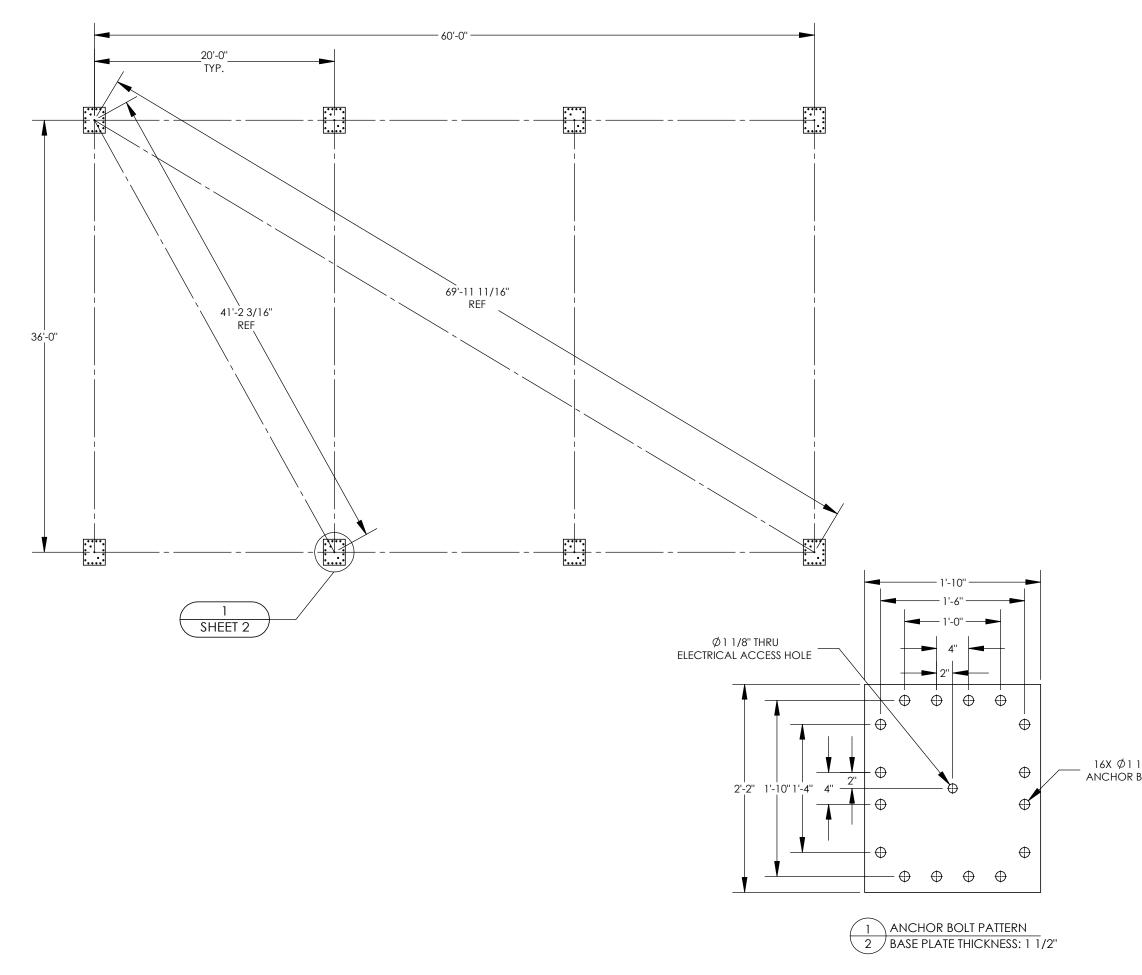

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ANCHO	R AND FOOTING LAYOUT NOTES:		WWW.POLIGON.COM	MAIN: (616) 888-3500 PORT: (616) 888-3504
1. AN	ICHORS MUST BE CENTERED IN OTINGS		V.POLIC	l: (616) T: (616)
2. FO WI	OTINGS MUST BE TURNED TO ALIGN	0		MAIN: (616) 888-3500 FIELD SUPPORT: (616) 888-3504
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				by PORTER CORP
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		r: Dell		
		DRAWN BY: dave.spel	REV LEVEL:	
			RE	35
		N DATE: 11/16/2016	о: 81859	^{DEL:} ~P21135
		CREATION DATE:	ORDER NO:	CAD MODEL:
			, UT	ANCHOR AND FOOTING LAYOUT
1/4'' THRU 30LT HOLE		CREEK	SALT LAKE CITY, UT	R AND FOOT
		PROJECT: PARLEY'S CREEK	PROJECT LOCATION: SAL	DRAWING: ANCHOR
			SHEET	l T
			2	
	IF THESE DRAWINGS ARE SEALED, THE SEAL APPLIES ONLY TO BUILDING COMPONENTS DETAILED WITHIN THESE DRAWINGS AND SUPPLIED BY PORTER CORP AS WELL AS THE FOUNDATION DESIGN, IF APPLICABLE.			

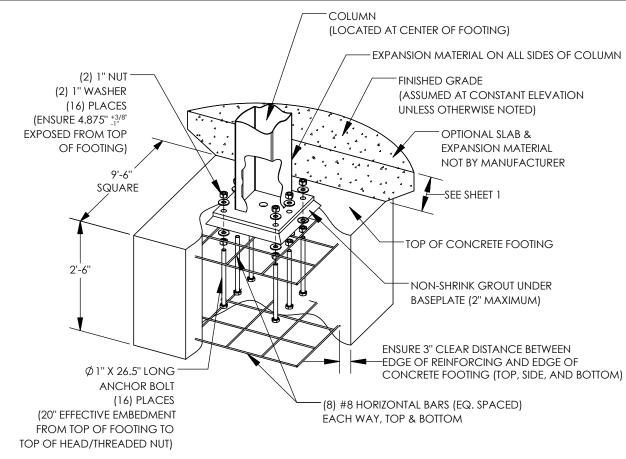

PAD FOOTING OPTION (EXTERNAL ANCHOR BOLTS)

FOOTING DESIGN BY MANUFACTURER, FOOTING MATERIALS BY OTHERS. (TYPICAL WITH EACH COLUMN, QTY OF REINFORCING AND ANCHOR BOLTS SPECIFIED IN NOTES REFLECT SITE SPECIFIC REQUIREMENTS)

ANCHOR BOLT NOTES - EXTERNAL (ANCHOR BOLTS LOCATED OUTSIDE COLUMN):

- 1. ANCHOR RODS TO BE ASTM F1554 GRADE 55 TYPE \$1 WITH "UNC" CLASS 2A THREADS, HEA' OTHERWISE NOTED.
- 2. ANCHOR BOLTS SHALL BE EITHER "HEADED" OR "THREADED WITH NUT" AS DEFINED IN THE A
- 3. HOOKED ANCHOR BOLTS ARE NOT ACCEPTABLE.
- 4. ACCURATE ANCHOR BOLT PLACEMENT IS CRITICAL. TO ENSURE THE ANCHOR BOLT LAYOU SURVEY (OR MEASURE) THE LOCATION OF ALL ANCHOR BOLTS PRIOR TO POURING THE FO SHOULD BE MADE AFTER THE FOOTINGS ARE POURED TO CONFIRM THE ANCHOR BOLTS DI
- 5. THE MANUFACTURER STRONGLY RECOMMENDS USING ANCHOR BOLT TEMPLATES BECAUSE ANCHOR BOLT PLACEMENT. AN ANCHOR BOLT TEMPLATE IS PROVIDED WITH ANY ANCHO
- 6. IF OUTSIDE CONSULTING ENGINEERS ARE DESIGNING THE FOUNDATIONS FOR THIS STRUCTU CALCULATIONS FOR MINIMUM CONCRETE PROPERTIES (COMPRESSIVE STRENGTH, EDGE D
- 7. ELECTRICAL ACCESS HOLE IS ALWAYS LOCATED IN THE COLUMN BASE PLATE AS SHOWN.
- 8. GROUT UNDER BASEPLATES SHALL BE NON-METALLIC, NON-SHRINK GROUT WITH MINIMUM
- 9. THE CALCULATIONS FOR THIS STRUCTURE ASSUME A FIXED COLUMN BASE.
- 10. ADHESIVE ANCHORS MAY NOT BE SUBSTITUTED FOR THE CAST-IN-PLACE ANCHORS.

CONCRETE NOTES:

- 1. ALL CONCRETE CONSTRUCTION SHALL CONFORM TO THE CURRENT "ACI MANUAL OF C
- 2. PORTLAND CEMENT SHALL CONFORM TO ASTM C-150 TYPE II OR TYPE V.
- 3. IT IS THE CONTRACTOR'S RESPONSIBILITY TO VERIFY THE CONCRETE MIX DESIGN MEETS TH FOR CONCRETE BY EXPOSURE CLASS.
- 4. THE USE OF CHLORIDE ACCELERATORS IS NOT PERMITTED.
- 5. COARSE AGGREGATE SHALL BE #57 OR LARGER.
- 6. CONCRETE AT PLACEMENT SHALL HAVE A SLUMP OF 4" +/- 1".
- 7. MINIMUM CONCRETE COMPRESSIVE STRENTGH AT 28 DAYS: 4500 PSI.
- REINFORCING STEEL SHALL BE DEFORMED STEEL CONFORMING TO THE REQUIREMENTS C ACCORDANCE WITH ASTM A305) AS FOLLOWS: GRADE 60: #4 BARS AND LARGER GRADE 40: #3 BARS
- 9. PRIOR TO PLACING OF CONCRETE, REINFORCING STEEL AND EMBEDDED ITEMS SHALL B
- 10. MAINTAIN 3" CONCRETE COVERAGE TO FACE OF BARS UNLESS OTHERWISE NOTED.
- 11. BARS SHALL BE CLEAN OF RUST, GREASE OR OTHER MATERIAL LIKELY TO IMPAIR BOND. B
- 12. WELDING OF REINFORCEMENT IS NOT ALLOWED.
- 13. ALL EXPOSED EXTERNAL CORNER OF FOUNDATIONS TO BE CHAMFERED BY 3/4" BY 45 DI
- 14. ALL NEW CONCRETE SHALL BE CURED IMMEDIATELY AFTER FINISHING OF REMOVING FO METHOD OR THE USE OF A CURING COMPOUND.

FOUNDATION NOTES:

- 1. FOUNDATIONS SHALL BEAR ON COMPETENT, UNDISTURBED SOIL OR 95% COMPAC IF SIGNS OF ORGANIC MATERIAL, UNCONTROLLED FILL, CLAY OR SILT, HIGH WATER OR OTHER POSSIBLE DETRIMENTAL CONDITIONS ARE FOUND, CONSTRUCTION OF T FOUNDATIONS MUST BE STOPPED AND A GEOTECHNICAL ENGINEER BE CONTACTE
- 2. NO FOUNDATIONS SHALL BE PLACED INTO OR ADJACENT TO SUBGRADE CONTAIN WATER, ICE, FROST, ORGANIC OR LOOSE MATERIAL.
- 3. WATER SHALL NOT BE PERMITTED TO ACCUMULATE IN FOUNDATION EXCAVATIONS
- 4. IT IS THE CONTRACTOR'S RESPONSIBILITY TO VERIFY THE LOCAL FROST DEPTH REQUI PRIOR TO CONSTRUCTION.
- 5. IF FOUNDATIONS SHOWN DO NOT MEET LOCAL FROST DEPTH REQUIREMENTS, EXTED DRILLED PIER FOUNDATION AS REQUIRED, EXTENDING THE VERTICAL BARS AND PRO ADDITIONAL TIES TO MEET SPACING REQUIREMENTS AS SHOWN. IF FROST DEPTH REQUIREMENTS ARE NOT MET, AND NO DRILLED PIER DESIGN IS PROVIDED, CONTAG POLIGON.
- 6. ALLOWABLE SOIL PRESSURES (AS APPLICABLE):


SPREAD PAD	
VERTICAL BEARING	1400 PSF
LATERAL COHESION	150 PSF

THE FOUNDATION DESIGN CONTAINED HEREIN IS SITE SPECIFIC, AND IS BASED ON GEOTECHNICAL ENGINEERING REPORT, SUGAR HOUSE PARK PAVILIONS, SALT LAK TERRACON. DATED 12/27/2024. REPORT NO. 61245209. PROPER CARE MUST BE TAKEN TO ENSURE ANY AND ALL RECOMMENDATIONS, OF ABOVE-MENTIONED REPORT, FOR SITE PREPARATION, SOIL PERFORMANCE AND FOUNDATION DESIGN ARE MET. IF CONDITIONS ARE PRESENT THAT DO NOT ALLOW THESE RECOMMENDATIONS TO BE MET, THE GEOTECHNICAL ENGINEER MUST BE CONTACTED.


AVY HEX NUTS AND STANDARD CUT WASHERS, UNLESS AMERICAN INSTITUTE OF STEEL CONSTRUCTION MANUAL. JT MEETS THE DIMENSIONS REQUIRED ON THE DRAWINGS, DOTINGS. AN ADDITIONAL SURVEY (OR MEASUREMENT) ID NOT SHIFT DURING THE CONCRETE POUR. SE THEY SIGNIFICANTLY IMPROVE THE ACCURACY OF DR BOLT KIT PURCHASED. JRE, THEY MUST REFER TO THE MANUFACTURER'S DISTANCE, ETC.) REQUIRED FOR THE ANCHOR BOLT DESIGN. <u>TEMPLATE MUST BE REMOVED BEFORE INSTALLING COLUMNS.</u> A f'C=6500 PSI.		Mon. Pollool www.Pollgon.com	MAIN: (616) 888-3500 by PORTER CORP FIELD SUPPORT: (616) 888-3504
CONCRETE PRACTICE". HE "ACI MANUAL OF CONCRETE PRACTICE" REQUIREMENTS	PRINT DATE: 2/7/2025	SCALE: 1:12	
DF ASTM A615 (DEFORMATIONS SHALL BE IN E WELL SECURED IN POSITION. BENDS SHALL BE MADE COLD.	CREATION DATE: DRAWN BY: 11/16/2016 dave.spell	NO: REV LEVEL: A 81859 A	^{лорен:} ~Р21135
EGREES UNLESS NOTED OTHERWISE. DRMWORK. CURING SHALL BE EITHER A MOIST CURE	CREATIO	ORDER NO:	CAD MODEL
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IF THESE DRAWINGS ARE SEALED, THE SEAL APPLIES ONLY TO BUILDING COMPONENTS DETAILED WITHIN THESE DRAWINGS AND SUPPLIED BY PORTER CORP AS WELL AS THE FOUNDATION DESIGN, IF APPLICABLE.		2.]

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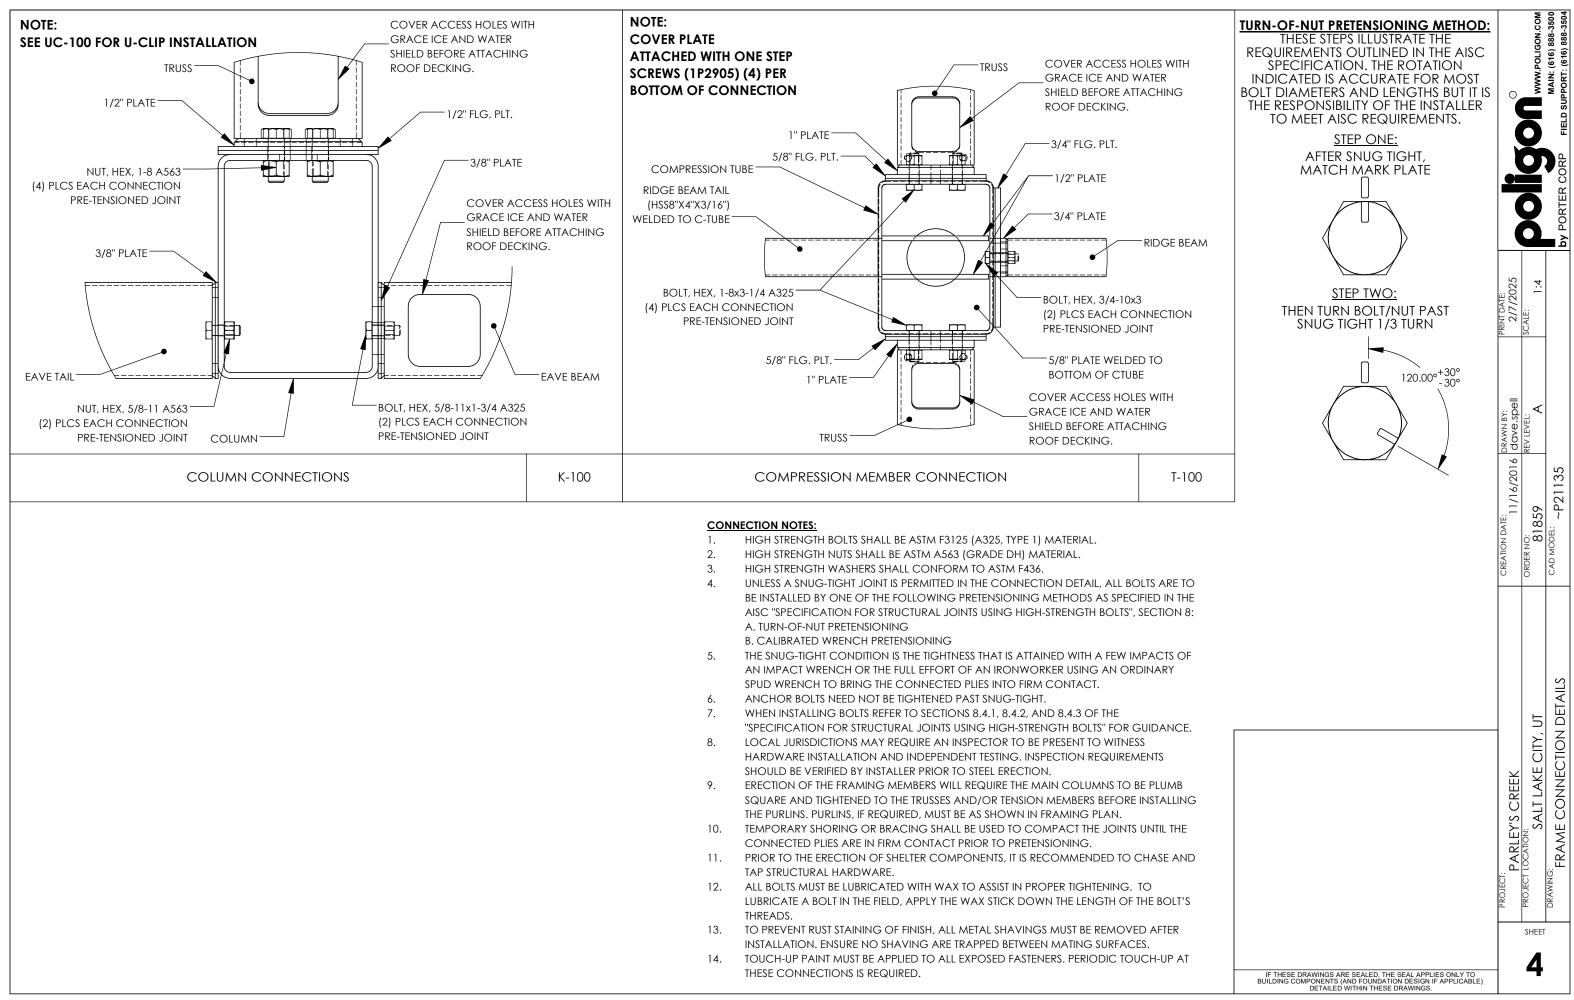
18	4	-	VERTICAL ORN ASM	HSS4"X2"X1/8"	414.47
17	2	-	BRACE 2 ASM	HSS5"X5"X3/8"	442.06
16	2	-	BRACE 1 ASM	HSS5"X5"X3/8"	442.06
15	2	-	EBEAM TAIL 2 ASM	HSS6"X6"X3/16"	26.46
14	2	-	EBEAM TAIL 1 ASM	HSS6"X6"X3/16"	26.46
13	2	-	RIDGE BEAM 2 ASM	HSS8"X4"X3/16"	281.58
12	1	-	RIDGE BEAM 1 ASM	HSS8"X4"X3/16"	282.08
11	2	-	C-TUBE 2 ASM	HSS16"X12"X3/8"	444.86
10	2	-	C-TUBE 1 ASM	HSS16"X12"X3/8"	443.83
9	12	-	PURLIN ASM	HSS8"X6"X3/16"	335.12
8	1	-	TRUSS 4 ASM	HSS20''X8''X3/8''	1402.67
7	4	-	TRUSS 3 ASM	HSS20''X8''X3/8''	1360.23
6	1	-	TRUSS 2 ASM	HSS20''X8''X3/8''	1404.42
5	2	-	truss 1 ASM	HSS20''X8''X3/8''	1402.84
4	6	-	TMEM ASM	HSS6"X6"X3/16"	280.51
3	4	-	COLUMN 3 ASM	HSS14"X10"X3/8"	968.47
2	2	-	COLUMN 2 ASM	HSS14"X10"X3/8"	968.64
1	2	-	COLUMN 1 ASM	HSS14"X10"X3/8"	968.64
ITEM	QTY.	PART NO.	DESCRIPTION	MATERIAL SIZE	WEIGHT

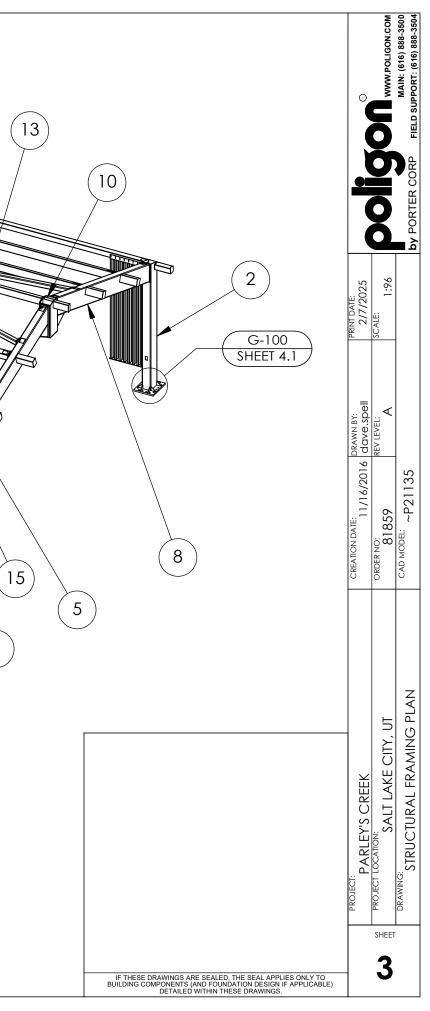


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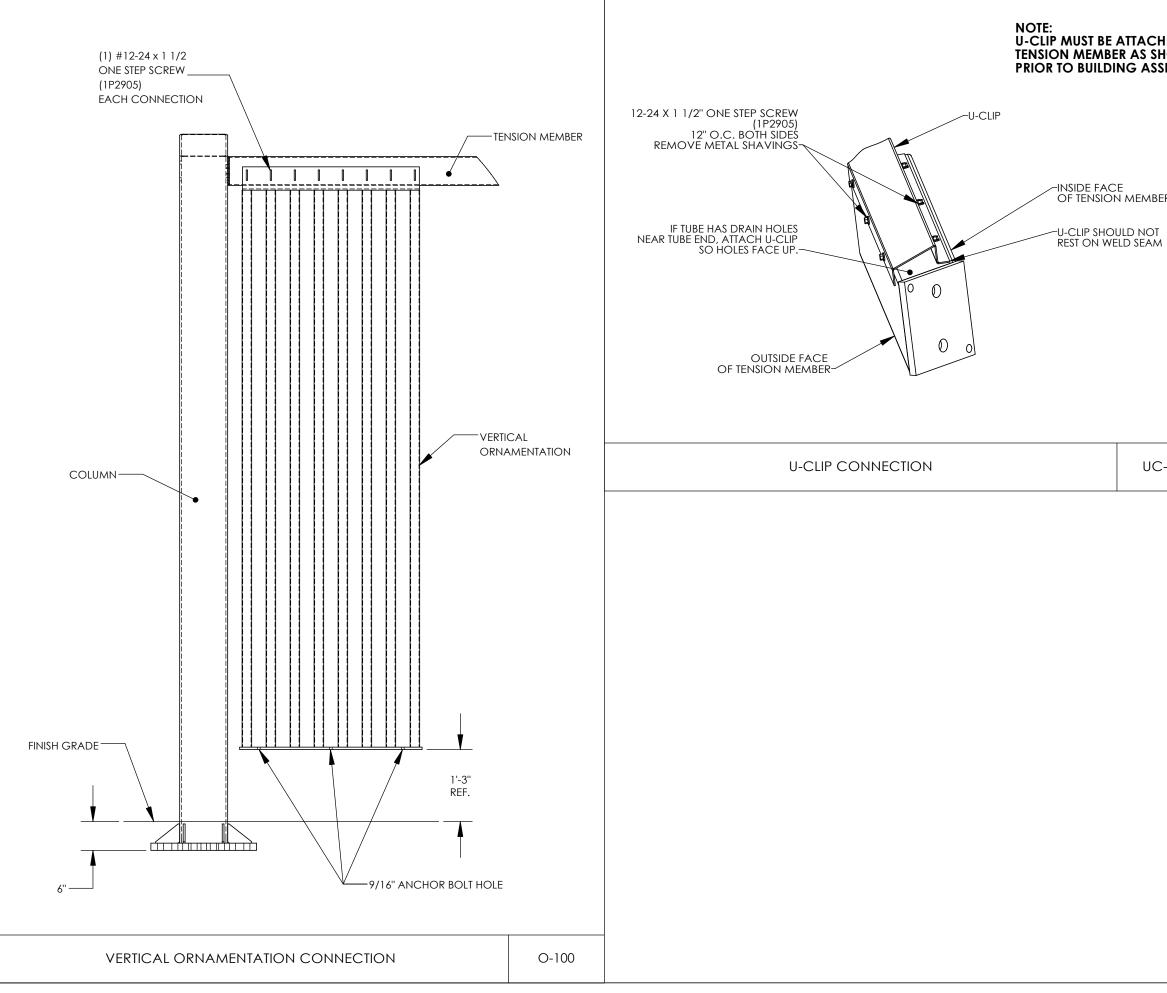


	by PORTER CORP FIELD SUPPORT: (616) 888-3504
	CREATION DATE: CREATION DATE:DRAWN BY: DAVE: DAVE:PRINT DATE: 2/7/20250 CDER NO:11/16/2016DAVE:Spell2/7/20250 REV LEVEL:REV LEVEL:2/7/20250 REV NO:REV LEVEL:1:1450 CAD MODEL:2011351:145
IF THESE DRAWINGS ARE SEALED, THE SEAL APPLIES ONLY TO BUILDING COMPONENTS (AND FOUNDATION DESIGN IF APPLICABL	PROJECT: PROJECT LOCATION: PROJECT LOCATION: SALT LAKE CITY, UT DRAWING: STRUCTURAL FRAMING PLAN

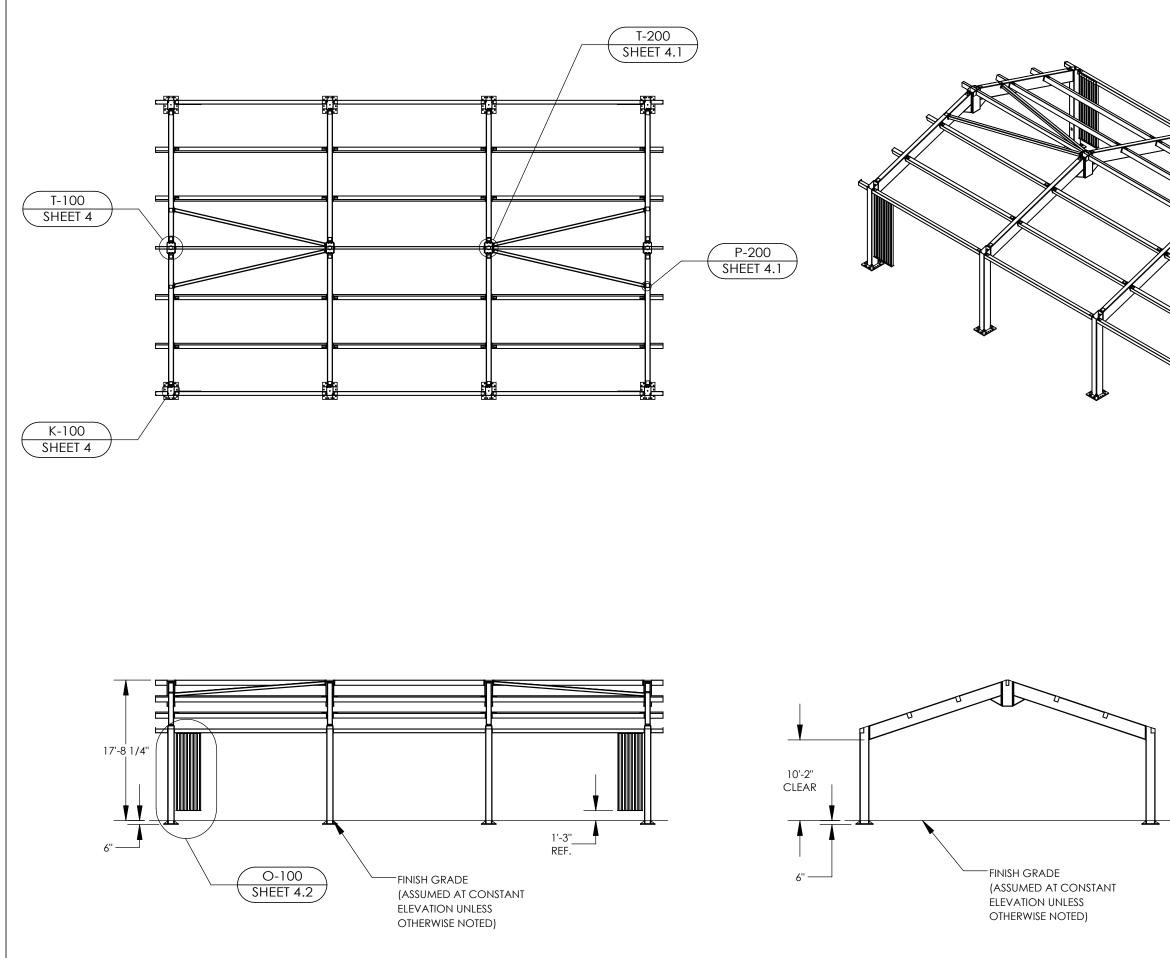


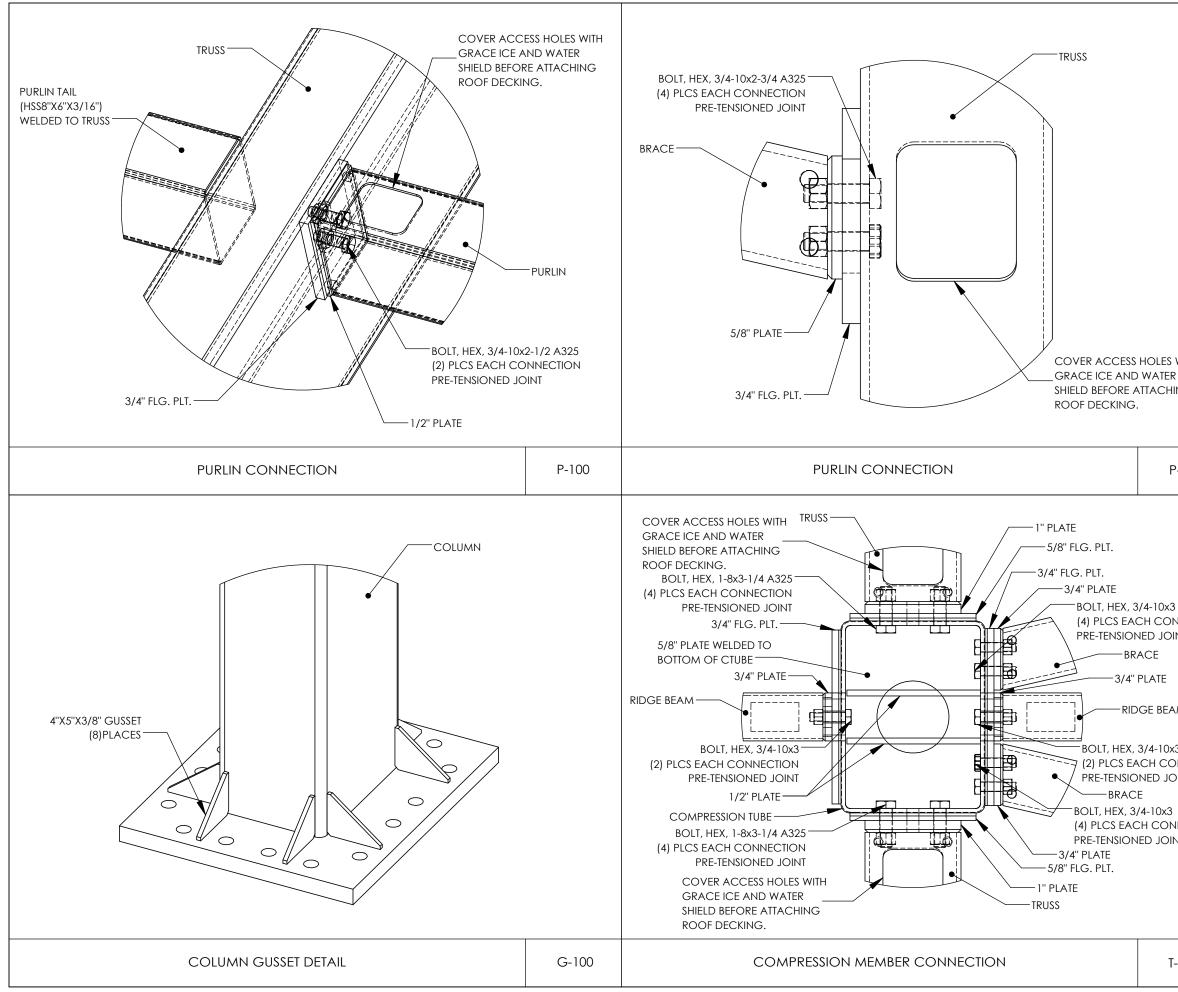


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WITH 2 ING 2-200		6/2016	359 REV LEVEL: A	~P21135
3 NNECTION		CREATION DATE:	ORDER NO: 81859	CAD MODEL:
M 3 DNNECTION DINT		REK	: SALT LAKE CITY, UT	FRAME CONNECTION DETAILS
INECTION NT		PROJECT: PARLEY'S CREEK	PROJECT LOCATION: SALT L	DRAWING: FRAME CON
-200	IF THESE DRAWINGS ARE SEALED, THE SEAL APPLIES ONLY TO BUILDING COMPONENTS (AND FOUNDATION DESIGN IF APPLICABLE) DETAILED WITHIN THESE DRAWINGS.	2	SHEET	




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EY'S CREEK SALT LAKE CITY, UT ME CONNECTION DETAILS	2-100	6/2016	REV LEVEL	CAD MODEL: ~P21135
PROJECT: PROJECT COCAT PROJECT LOCAT			PROJECT LOCATION	drawing: FRAM

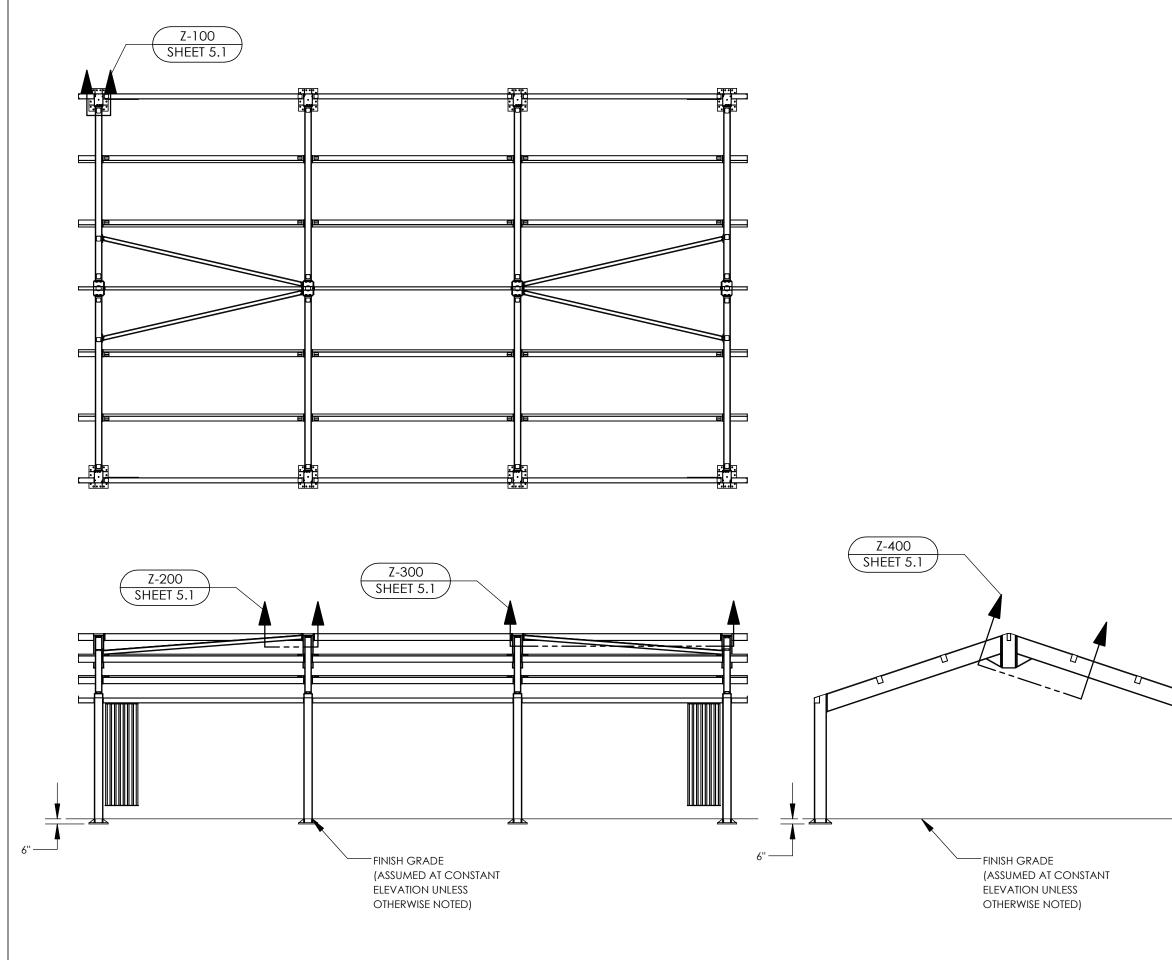


	0		MAIN: (616) 888-3500 by PORTER CORP FIELD SUPPORT: (616) 888-3504
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	CREATION DATE: DRAWN BY: 11/16/2016 dave.spell	ORDER NO: REV LEVEL: A	CAD MODEL: ~P21135
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IF THESE DRAWINGS ARE SEALED. THE SEAL APPLIES ONLY TO BUILDING COMPONENTS (AND FOUNDATION DESIGN IF APPLICABLE) DETAILED WITHIN THESE DRAWINGS.		J	

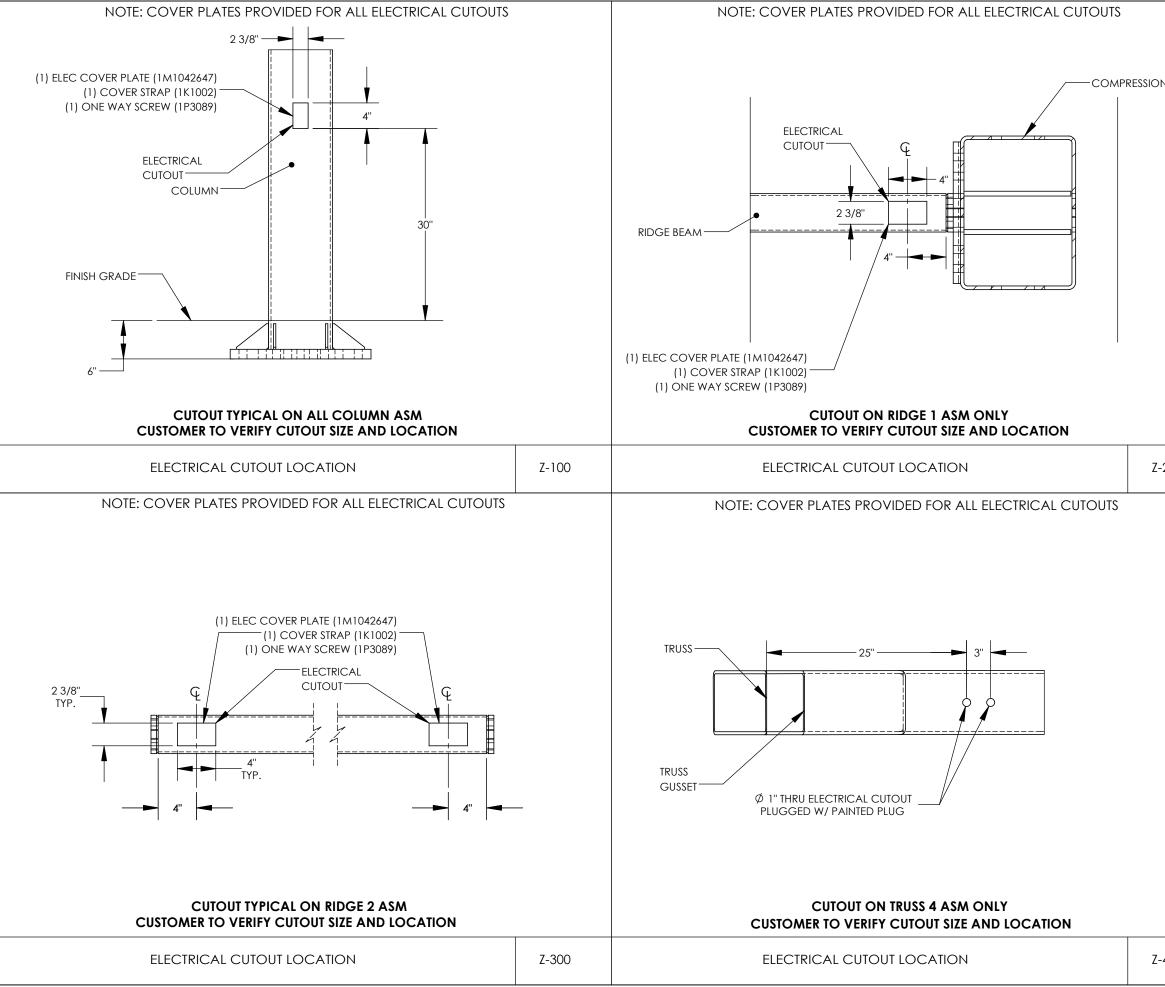


N TUBE		0		MAIN: (616) 888-3500 FIELD SUPPORT: (616) 888-3504
				by PORTER CORP
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200		: 11/16/2016 dave.spell	REV LEVEL:	35
		DATE	ORDER NO: 81859	CAD MODEL: ~P21135
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		PROJECT: PARLEY'S CREEK	PROJECT LOCATION: SALT LAKE CITY, UT	DRAWING: ELECTRICAL VIEWS
400	IF THESE DRAWINGS ARE SEALED, THE SEAL APPLIES ONLY TO BUILDING COMPONENTS (AND FOUNDATION DESIGN IF APPLICABLE) DETAILED WITHIN THESE DRAWINGS.	Į	SHEET	

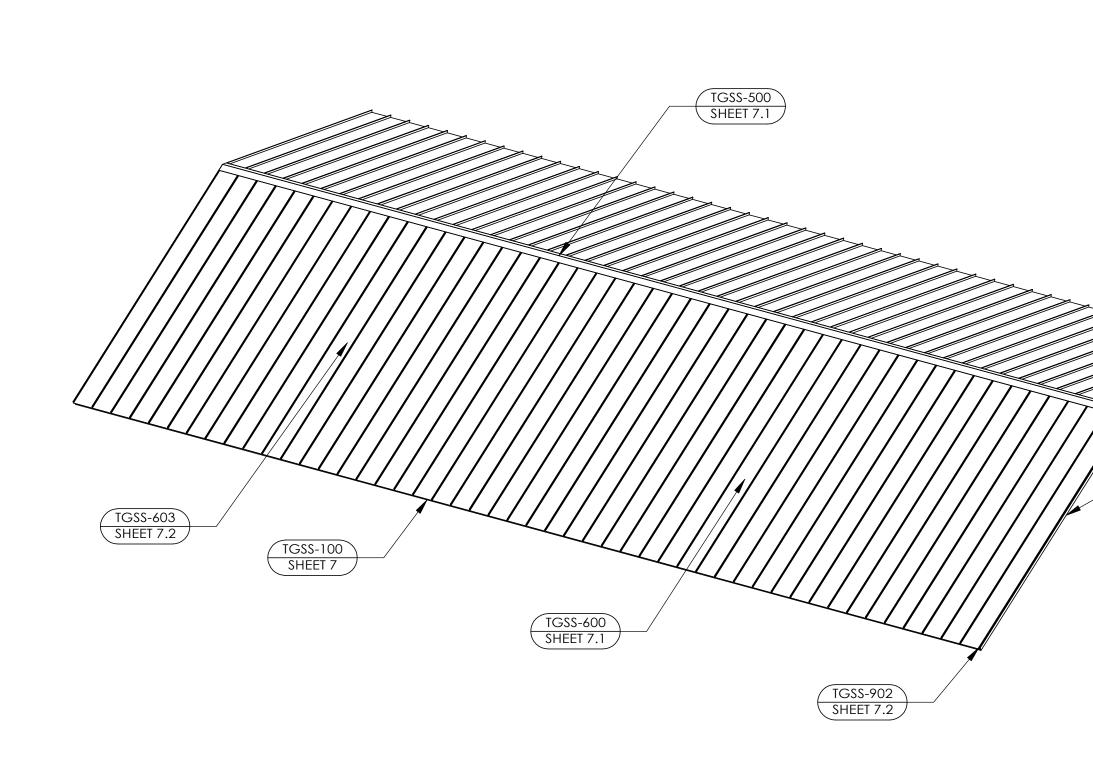

	by PORTER CORP FIELD SUPPORT: (616) 888-3500
	PRINT DATE: 2/7/2025 SCALE: 1:72 by
TGSS-400 SHEET 7	CREATION DATE: 11/16/2016 DRAWN BY: 0RDER NO: 81859 AEV LEVEL: CAD MODEL: ~P21135
	PROJECT: PROJECT LOCATION: SALT LAKE CITY, UT DRAWING: ROOF OVERVIEW

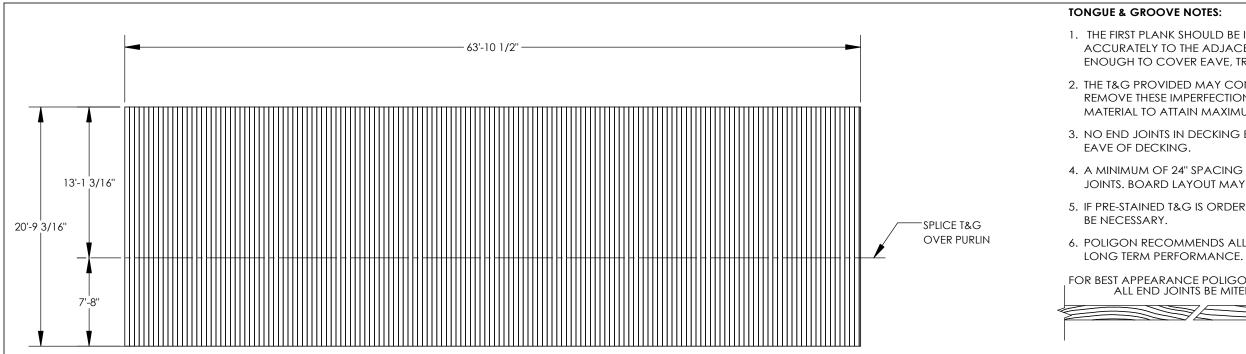

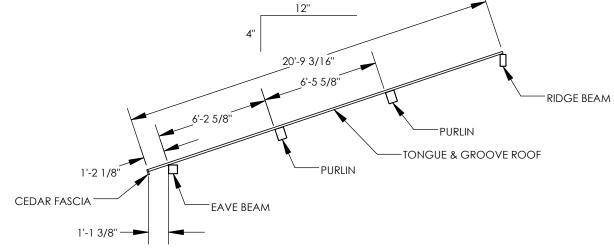

1. THE FIRST PLANK SHOULD BE INSTALLED PLUMB, STRAIGHT, AND ACCURATELY TO THE ADJACENT WORK. MAKE SURE PLANKS EXTEND ENOUGH TO COVER EAVE, TRUSSES, AND/OR THE CENTER OF THE PEAK.

2. THE T&G PROVIDED MAY CONTAIN SOME MINOR IMPERFECTIONS. REMOVE THESE IMPERFECTIONS AS REQUIRED AND USE REMAINDER OF MATERIAL TO ATTAIN MAXIMUM YIELD.

3. NO END JOINTS IN DECKING BETWEEN STRUCTURAL FRAMING AND

4. A MINIMUM OF 24" SPACING IS REQUIRED BETWEEN ALL ADJACENT END JOINTS. BOARD LAYOUT MAY REQUIRE VISIBLE SPLICES.


5. IF PRE-STAINED T&G IS ORDERED, TOUCH-UP AT FIELD CUT EDGES MAY


6. POLIGON RECOMMENDS ALL T&G BE STAINED/SEALED TO IMPROVE

FOR BEST APPEARANCE POLIGON SUGGESTS THAT ALL END JOINTS BE MITERED @ 45°

NSTALLED PLUMB, STRAIGHT, AND ENT WORK. MAKE SURE PLANKS EXTEND PUSSES, AND/OR THE CENTER OF THE PEAK. NTAIN SOME MINOR IMPERFECTIONS. NS AS REQUIRED AND USE REMAINDER OF IM YIELD. BETWEEN STRUCTURAL FRAMING AND IS REQUIRED BETWEEN ALL ADJACENT END REQUIRE VISIBLE SPLICES. ED, TOUCH-UP AT FIELD CUT EDGES MAY			by PORTER CORP FIELD SUPPORT: (616) 888-350	
IN SUGGESTS THAT RED @ 45°	PRINT DATE: 2/7/2025	SCALE: 1:100		
	CREATION DATE: DRAWN BY: 11/16/2016 dave.spell	ORDER NO: REV LEVEL: 81859 A	CAD MODEL: ~P21135	
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STANDING SEAM INSTALLATION NOTES:

THE DETAILS SHOWN ARE SUGGESTIONS OR GUIDELINES ON HOW ERECT THE SYSTEMS. THE INFORMATION SHOWN IS ACCURATE, BUT I IS NOT INTENDED TO COVER ALL INSTANCES, BUILDING REQUIREMENTS, DESIGNS OR CODES. THE DETAILS MAY REQUIRE CHANGES OR REVISIONS DUE TO FIELD CONDITIONS.

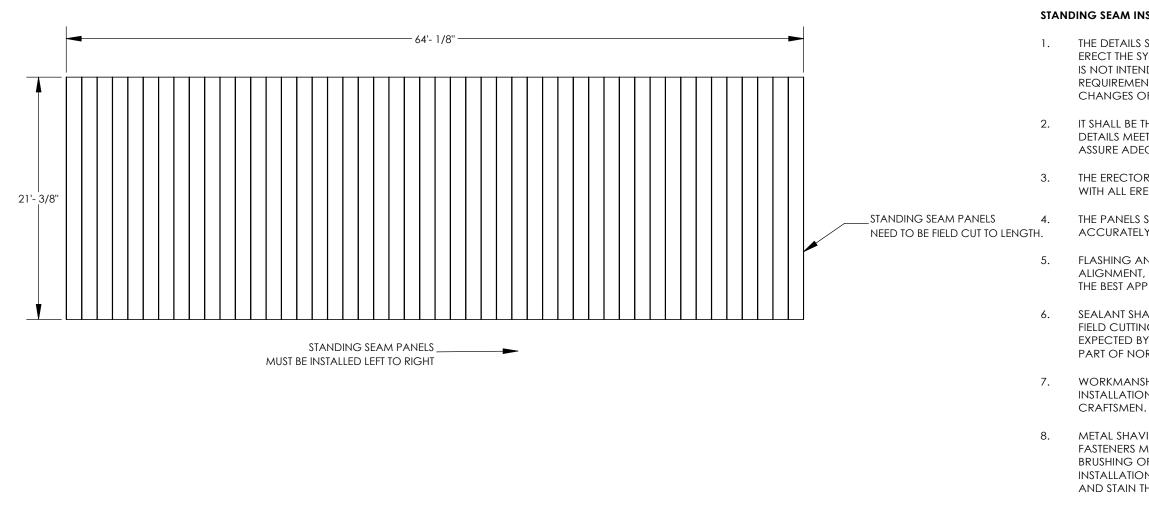IT SHALL BE THE RESPONSIBILITY OF THE ERECTOR TO ENSURE THAT TH DETAILS MEET PARTICULAR BUILDING REQUIREMENTS AND TO ASSURE ADEQUATE WATER TIGHTNESS.

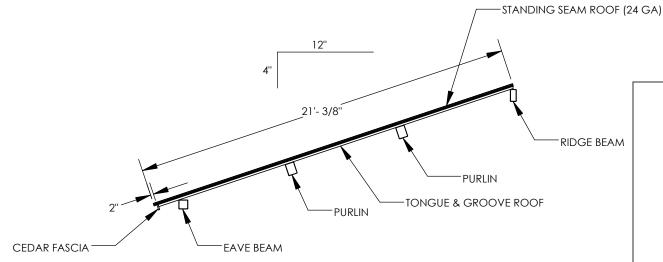THE ERECTOR SHOULD THOROUGHLY FAMILIARIZE HIMSELF/HERSELF WITH ALL ERECTION INSTRUCTIONS BEFORE STARTING WORK.

THE PANELS SHOULD BE INSTALLED PLUMB, STRAIGHT, AND ACCURATELY TO THE ADJACENT WORK.

FLASHING AND TRIM SHALL BE INSTALLED TRUE, AND IN PROPER ALIGNMENT, WITH ANY EXPOSED FASTENERS EQUALLY SPACED FOR THE BEST APPEARANCE.


SEALANT SHALL BE FIELD APPLIED ON DRY, CLEAN SURFACES. SOMI FIELD CUTTING AND FITTING OF PANELS AND FLASHING IS TO BE EXPECTED BY THE ERECTOR AND MINOR FIELD CORRECTIONS ARE PART OF NORMAL ERECTION WORK.


WORKMANSHIP SHALL BE OF THE BEST INDUSTRY STANDARDS AND INSTALLATION SHALL BE PERFORMED BY EXPERIENCED METAL

METAL SHAVINGS FROM DRILLING OR INSTALLATION OF ROOF FASTENERS MUST BE CAREFULLY REMOVED FROM THE ROOF BY BRUSHING OR SWEEPING AT THE END OF EACH DAY DURING INSTALLATION. SHAVINGS LEFT ON THE ROOF WILL QUICKLY RUST AND STAIN THE ROOF FINISH.


NOTES:		GON.COM	888-350 () 888-350	
SUGGESTIONS OR GUIDELINES ON HOW TO NFORMATION SHOWN IS ACCURATE, BUT IT 'ER ALL INSTANCES, BUILDING OR CODES. THE DETAILS MAY REQUIRE DUE TO FIELD CONDITIONS.	G		MAIN: (616) 888-350 FIELD SUPPORT: (616) 888-350	
BILITY OF THE ERECTOR TO ENSURE THAT THE R BUILDING REQUIREMENTS AND TO R TIGHTNESS.				
OROUGHLY FAMILIARIZE HIMSELF/HERSELF		Q	by PORTER CORP	
ISTALLED PLUMB, STRAIGHT, AND JACENT WORK.		0	∎ Pd Bd	
L BE INSTALLED TRUE, AND IN PROPER XPOSED FASTENERS EQUALLY SPACED FOR	√T DATE: 2/7/2025	1:100		
APPLIED ON DRY, CLEAN SURFACES. SOME G OF PANELS AND FLASHING IS TO BE IR AND MINOR FIELD CORRECTIONS ARE A ON WORK.	PRINT DATE 2/7/20	SCALE:		
OF THE BEST INDUSTRY STANDARDS AND ERFORMED BY EXPERIENCED METAL	DRAWN BY: dave.spell	REV LEVEL: A		
DRILLING OR INSTALLATION OF ROOF FULLY REMOVED FROM THE ROOF BY AT THE END OF EACH DAY DURING LEFT ON THE ROOF WILL QUICKLY RUST SH.	CREATION DATE: 11/16/2016 dav	ORDER NO: REV LI 81859	CAD MODEL: ~P21135	
۹)		, UT		
	PROJECT			
IF THESE DRAWINGS ARE SEALED, THE SEAL APPLIES ONLY TO BUILDING COMPONENTS (AND FOUNDATION DESIGN IF APPLICABLE) DETAILED WITHIN THESE DRAWINGS.	C).4		

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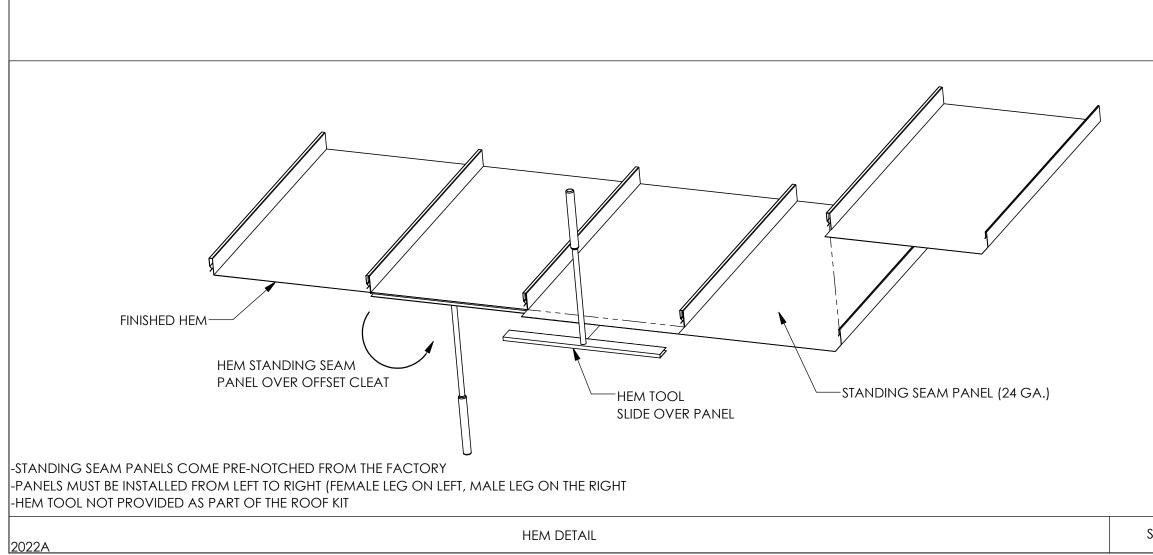


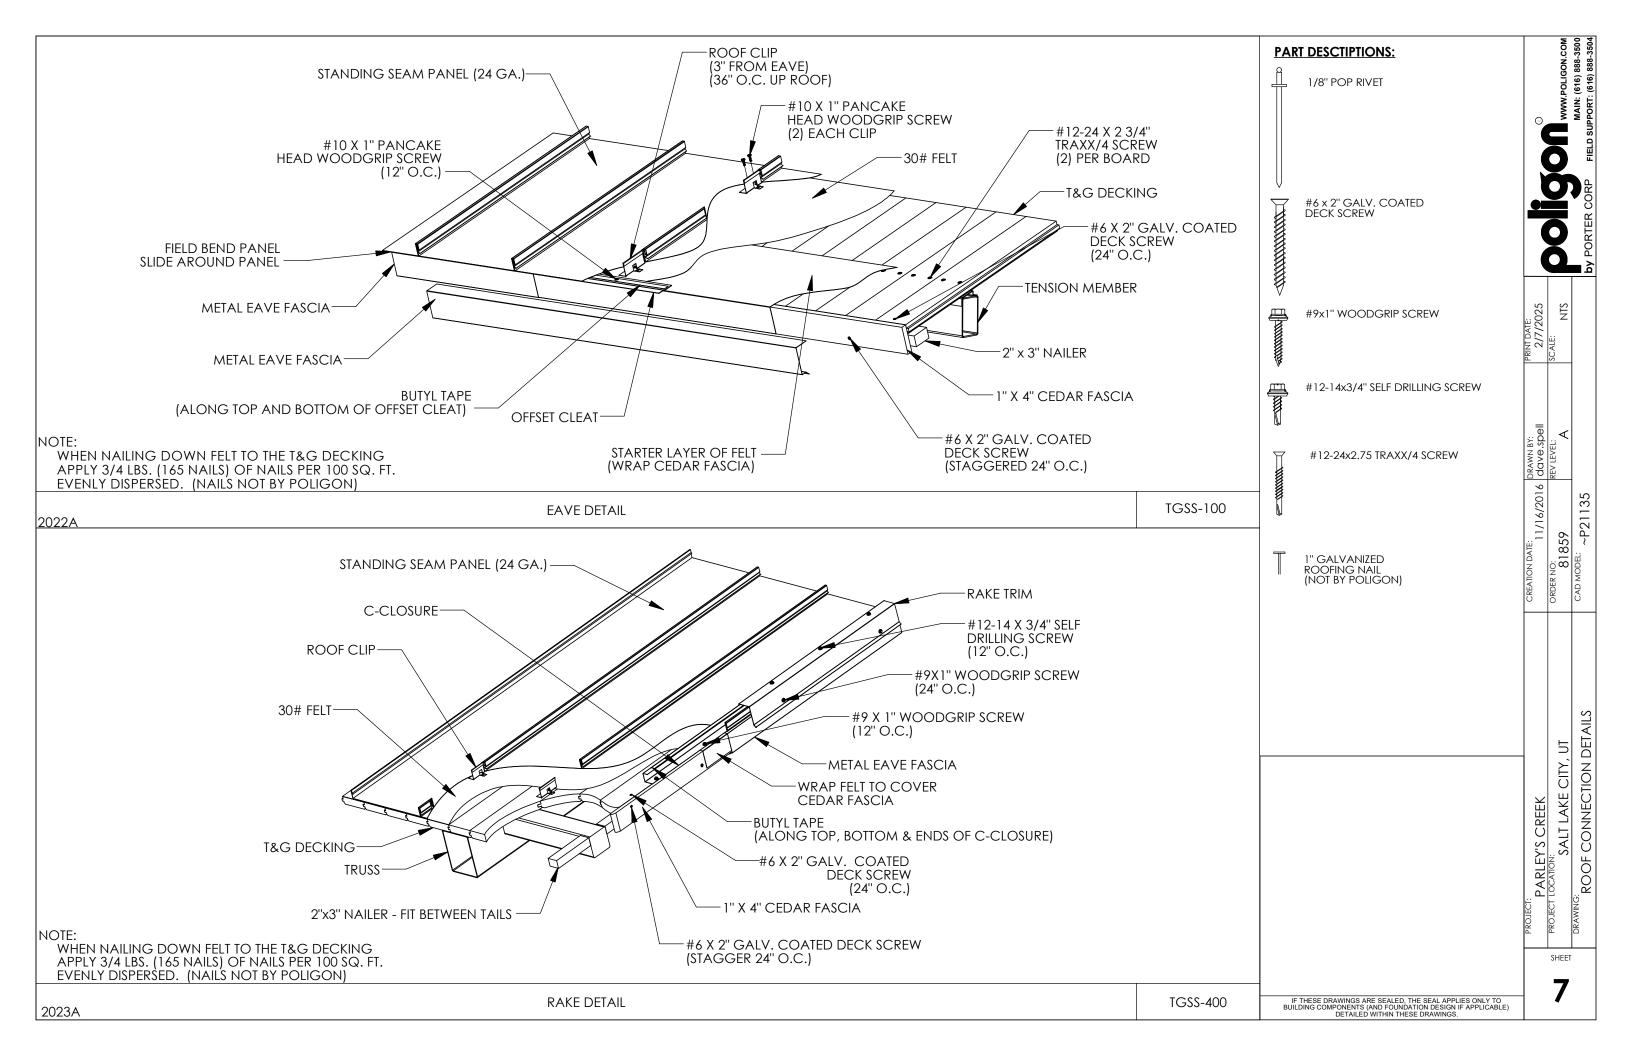

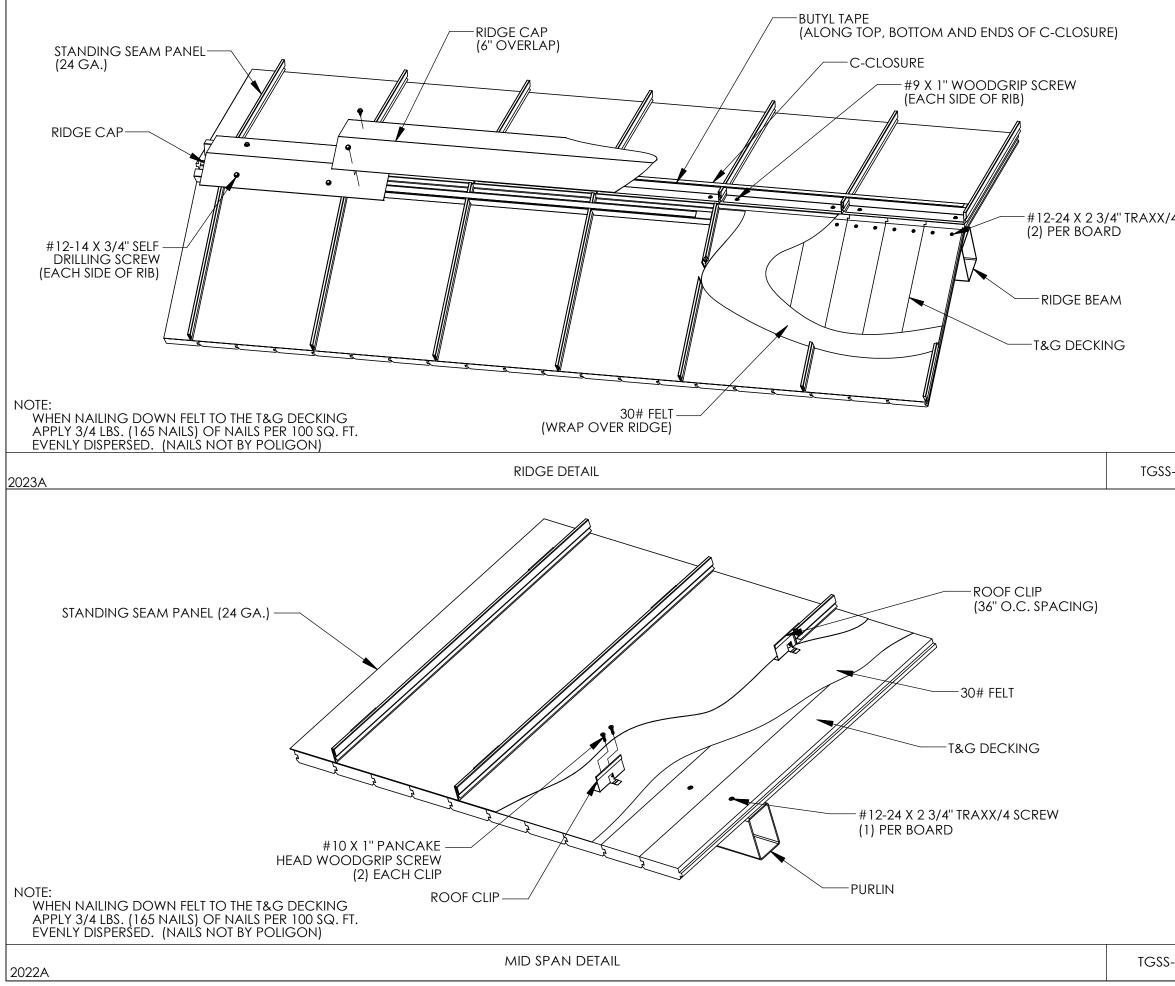4 SCREW				MAIN: (616) 888-3500 by PORTER CORP FIELD SUPPORT: (616) 888-3504
		PRINT DATE: 2/7/2025	SCALE: NTS	
		l6 dave.spell	REV LEVEL:	
5-500		CREATION DATE: 11/16/2016	ORDER NO: 81859	CAD MODEL: ~P21135
		PROJECT: PARLEY'S CREEK	CITY, UT	AILS
-600	IF THESE DRAWINGS ARE SEALED. THE SEAL APPLIES ONLY TO BUILDING COMPONENTS (AND FOUNDATION DESIGN IF APPLICABLE) DETAILED WITHIN THESE DRAWINGS.		SHEET	

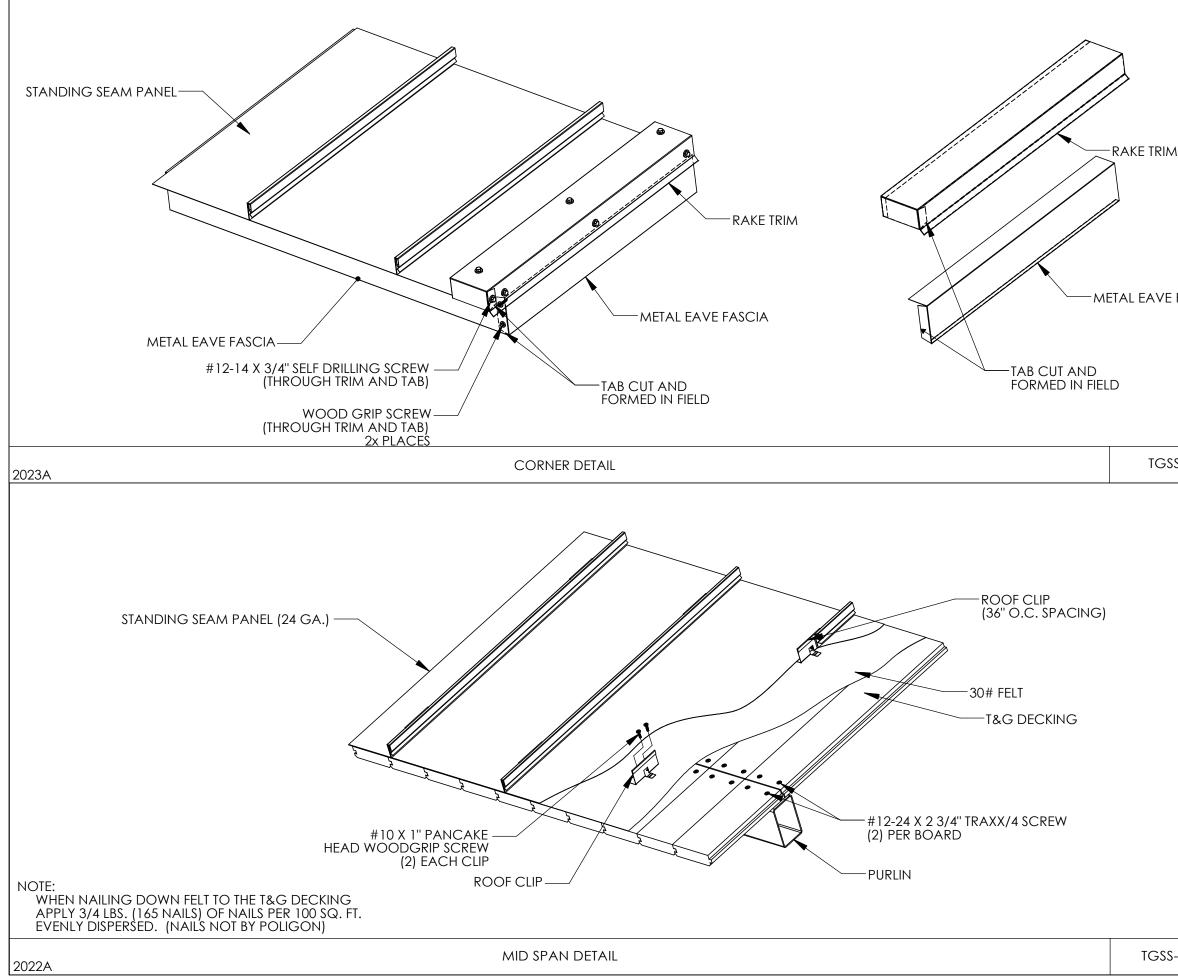

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Fascia		PRINT DATE: 2/7/2025	SCALE: NTS	by PORTER CORP
S-902		CREATION DATE: DRAWN BY: 11/16/2016 dave.spell	ORDER NO: 81859 REV LEVEL: A	сар морен: ~P21135
			PROJECT LOCATION: SALT LAKE CITY, UT	DRAWING: ROOF CONNECTION DETAILS
-603	IF THESE DRAWINGS ARE SEALED. THE SEAL APPLIES ONLY TO BUILDING COMPONENTS (AND FOUNDATION DESIGN IF APPLICABLE) DETAILED WITHIN THESE DRAWINGS.		SHEET	



			DOIOD MWW.POLIGON.COM	by PORTER CORP FIELD SUPPORT: (616) 888-3500
		PRINT DATE: 2/7/2025	scale: NTS	
		CREATION DATE: DRAWN BY: 11/16/2016 dave.spell	ORDER NO: 81859 REV LEVEL: A	CAD MODEL: ~P21135
			PROJECT LOCATION: SALT LAKE CITY, UT	DRAWING: ROOF CONNECTION DETAILS
EM	IF THESE DRAWINGS ARE SEALED, THE SEAL APPLIES ONLY TO BUILDING COMPONENTS (AND FOUNDATION DESIGN IF APPLICABLE) DETAILED WITHIN THESE DRAWINGS.		SHEET	